THIS E COPY OF BID DOCUMENT IS FOR INFORMATION AND INSPECTION TO THE PROSPECTIVE BIDDERS. BIDDERS MUST PURCHASE BID DOCUMENT FROM ALTERNATIVE ENERGY PROMOTION CENTER (AEPC) AS INDICATED IN THE BID NOTICE FOR BIDDING.

SANIVERI UTTARGANGA MINI HYDROPOWER **PROJECT**


STRUCTURAL DRAWINGS


March 2019


LIST OF DRAWINGS PROJECT : SANIVERI UTTARGANGA MINI HYDROPOWER PROJECT


S.N	DRAWING NUMBER	DRAWING TITLE
		LIE A DIMORNO
1	CLIMUD/DED 050 04 to 02	HEADWORKS
	SUMHP/DED-05S-01 to 03	Weir and Undersluice: Sections
2		INTAKE & UNDERSLUCIE
	SUMHP/DED-10S-01	Intake Gate and Undersluice Gate Portion: Plan & Sections
3		GRAVEL TRAP
	SUMHP/DED-15S-01	Gravel Trap Typical Section
4		APPROACH CANAL
	SUMHP/DED-20S-01	Typical Section of Approach Canal
5		SETTLING BASIN
	SUMHP/DED-25S-01	Settling basin: Plan And Profile
	SUMHP/DED-25S-02	Settling basin: Sections
	SUMHP/DED-25S-03	Settling basin: Flushing arrangement, plan and sections


S.N	DRAWING NUMBER	DRAWING TITLE				
6		HEADRACE CANAL				
	SUMHP/DED-30S-01	Headrace canal: General plan				
	SUMHP/DED-30S-02	Headrace canal: Typical sections				
7		FOREBAY				
	SUMHP/DED-35S-01	Forebay: Plan and Profile				
	SUMHP/DED-35S-02	Forebay: Sections				
8		POWERHOUSE				
	SUMHP/DED-55A-01 to 02	Powerhouse: Machine Foundation				
	SUMHP/DED-55B-01	Powerhouse: Foundation and Column				
	SUMHP/DED-55C-01	Powerhouse: Foundation Tie Beam				
	SUMHP/DED-55D-01	Powerhouse: Floor Beams				
	SUMHP/DED-55E-01	Powerhouse: Roof Details				

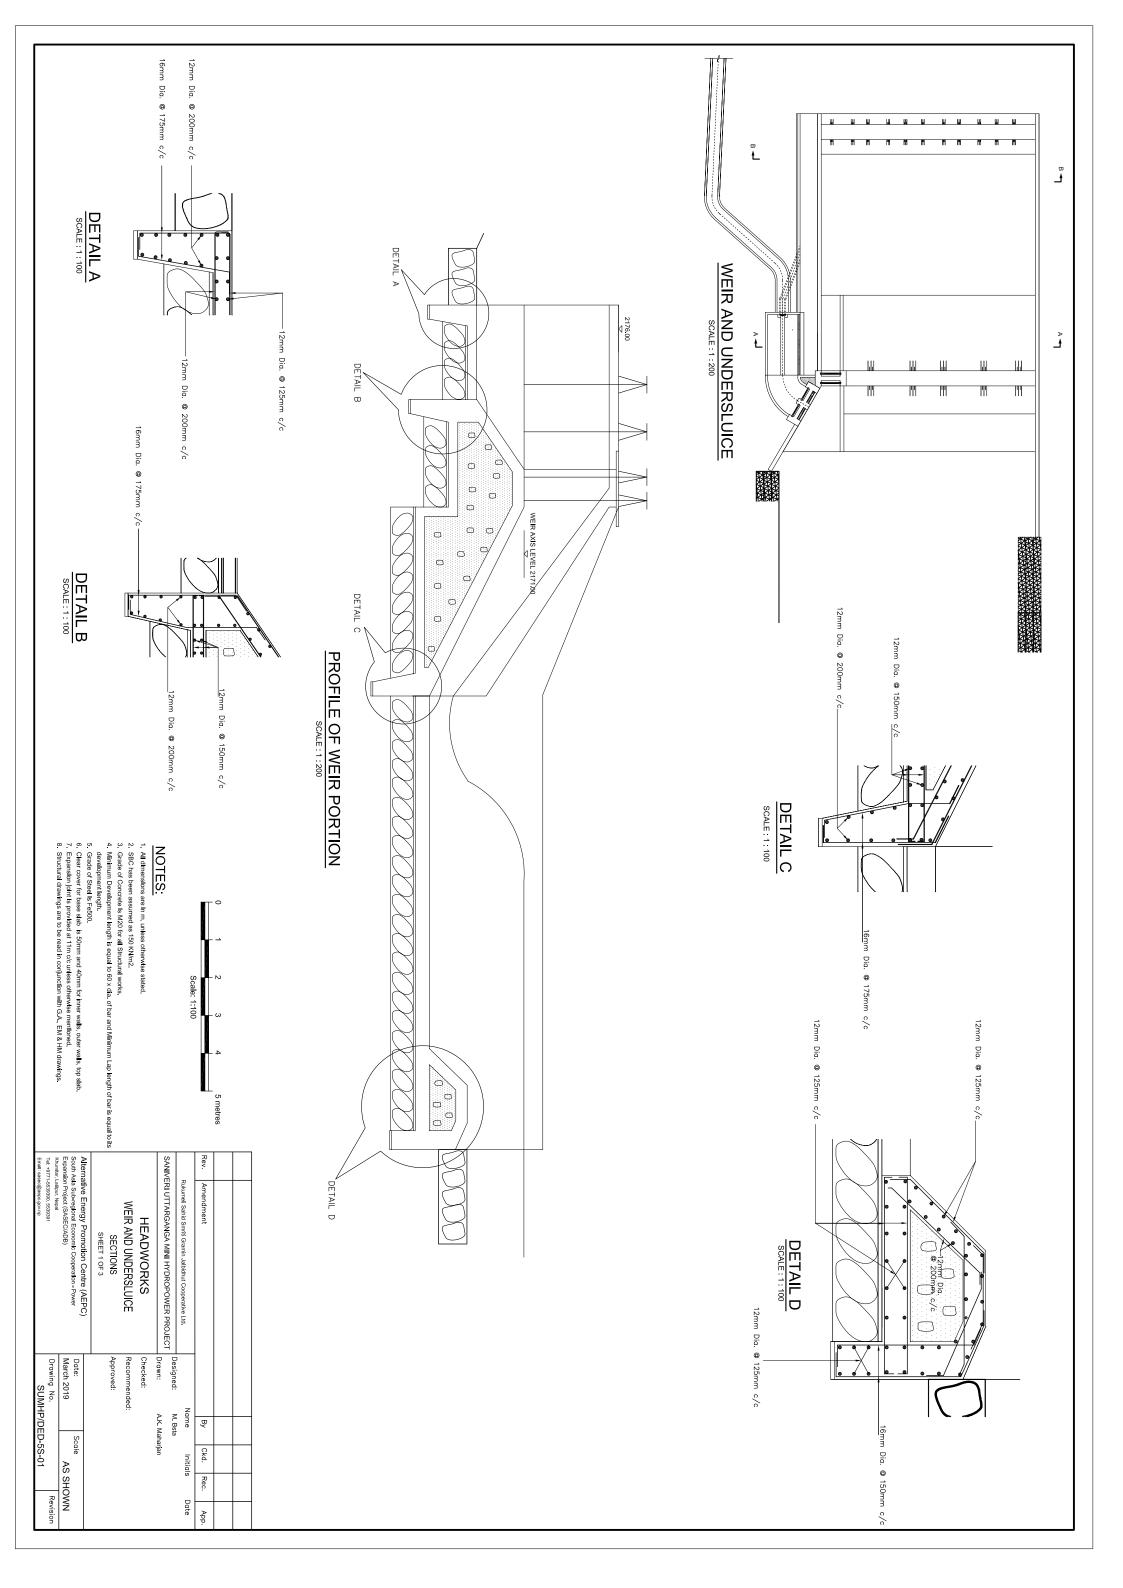

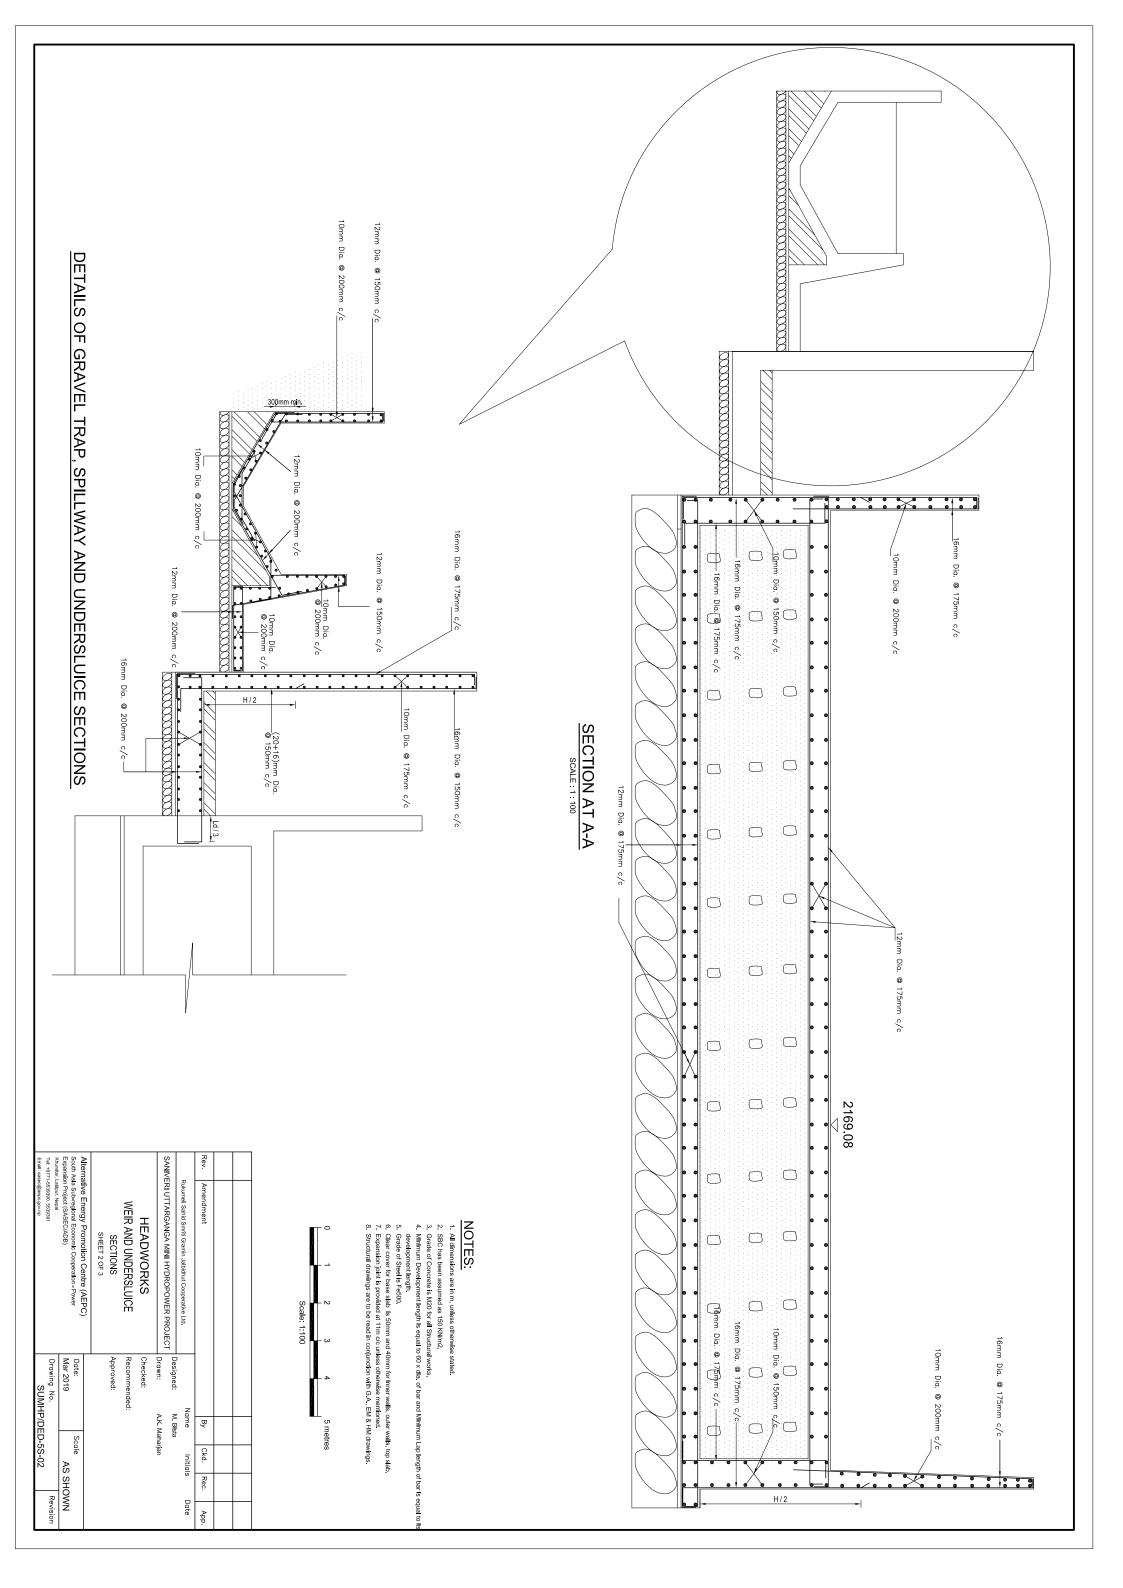


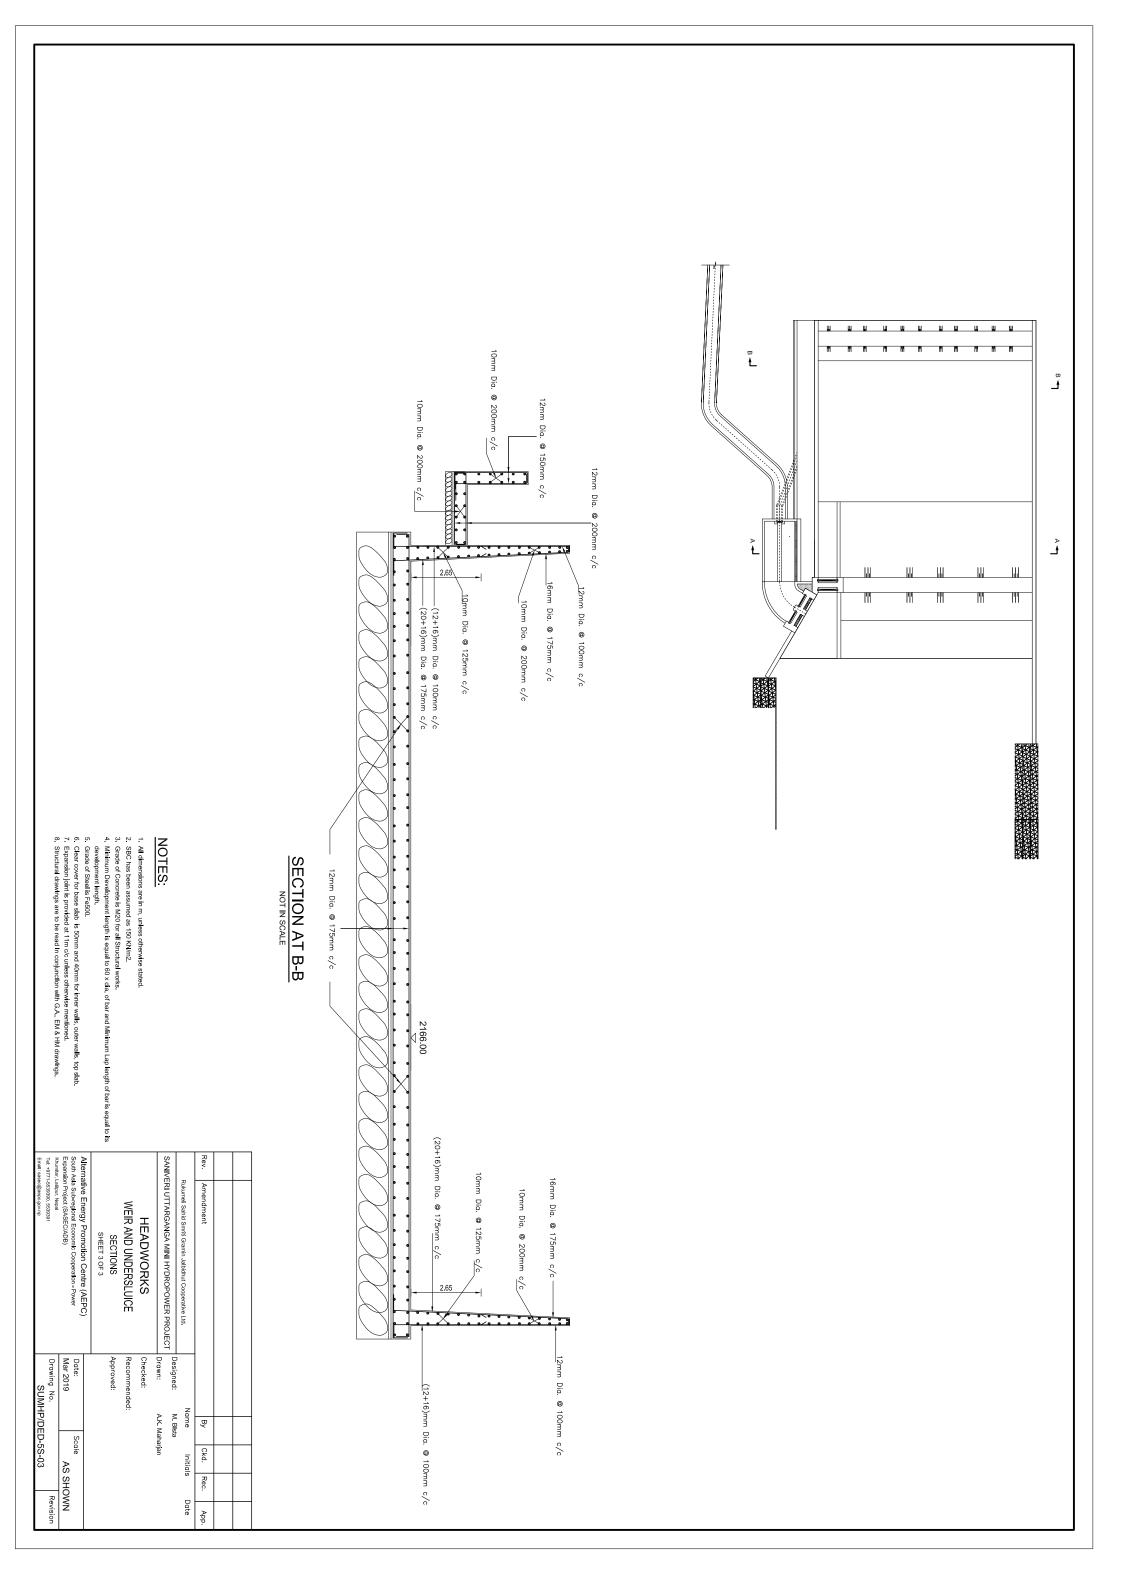


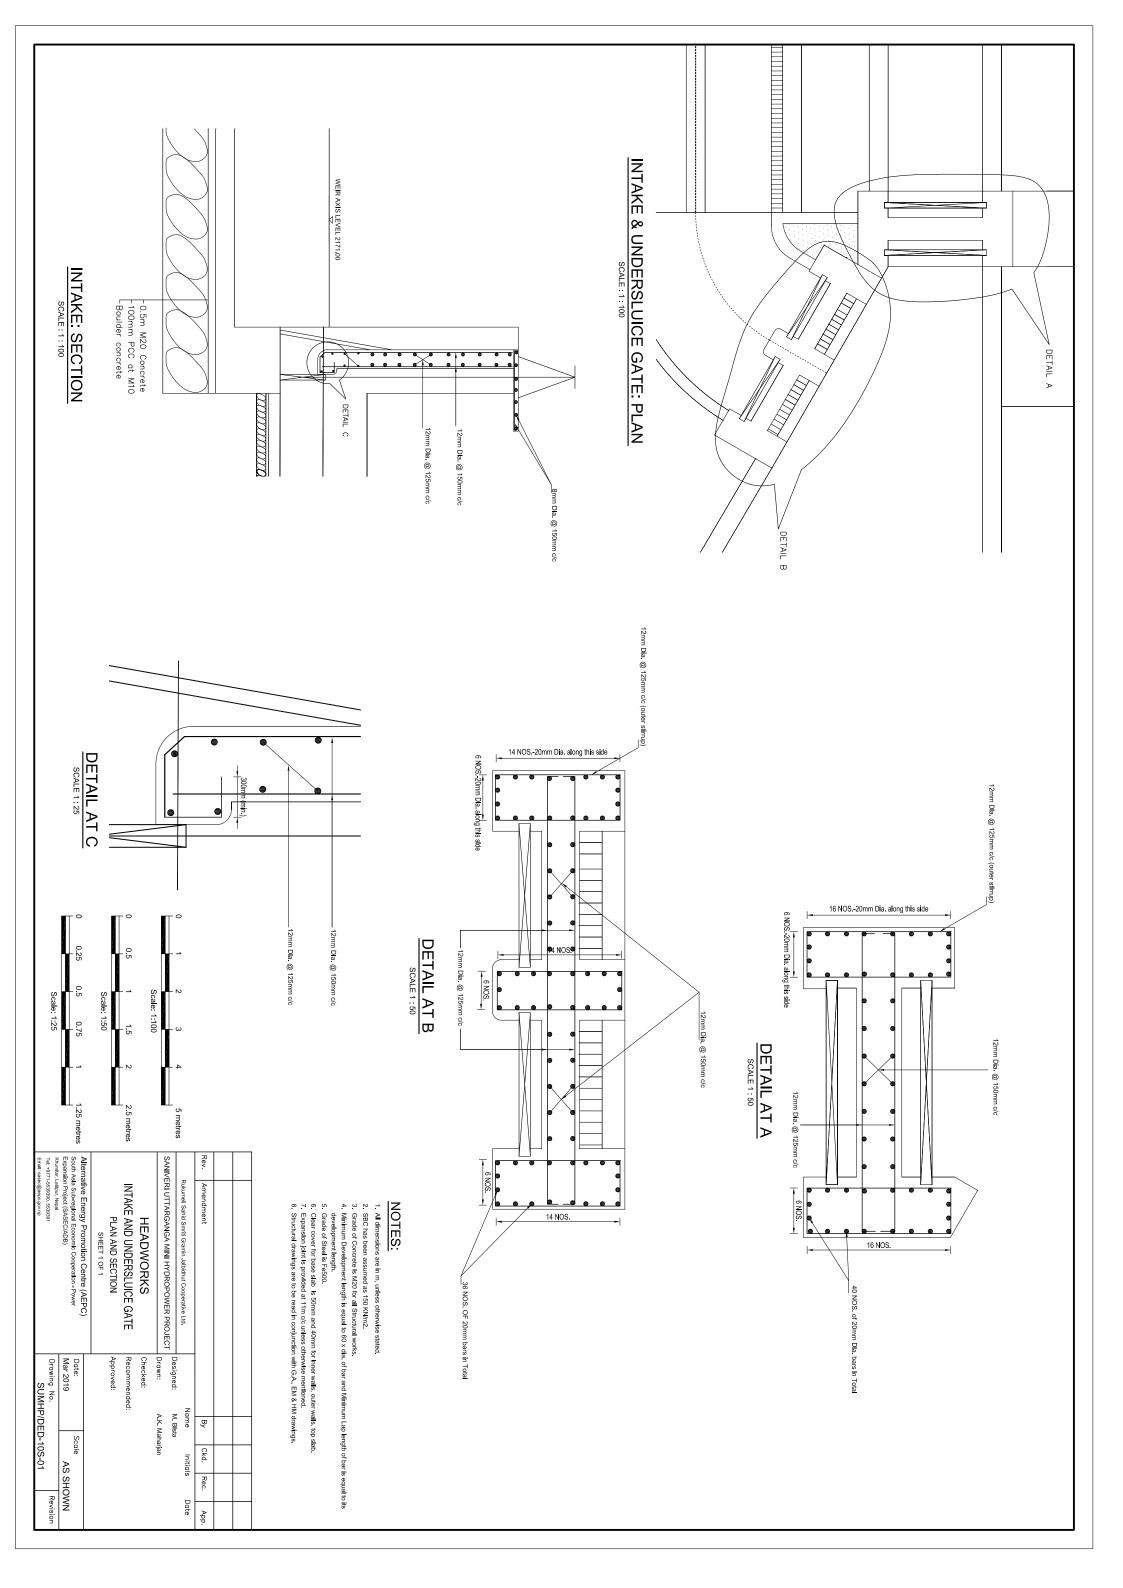


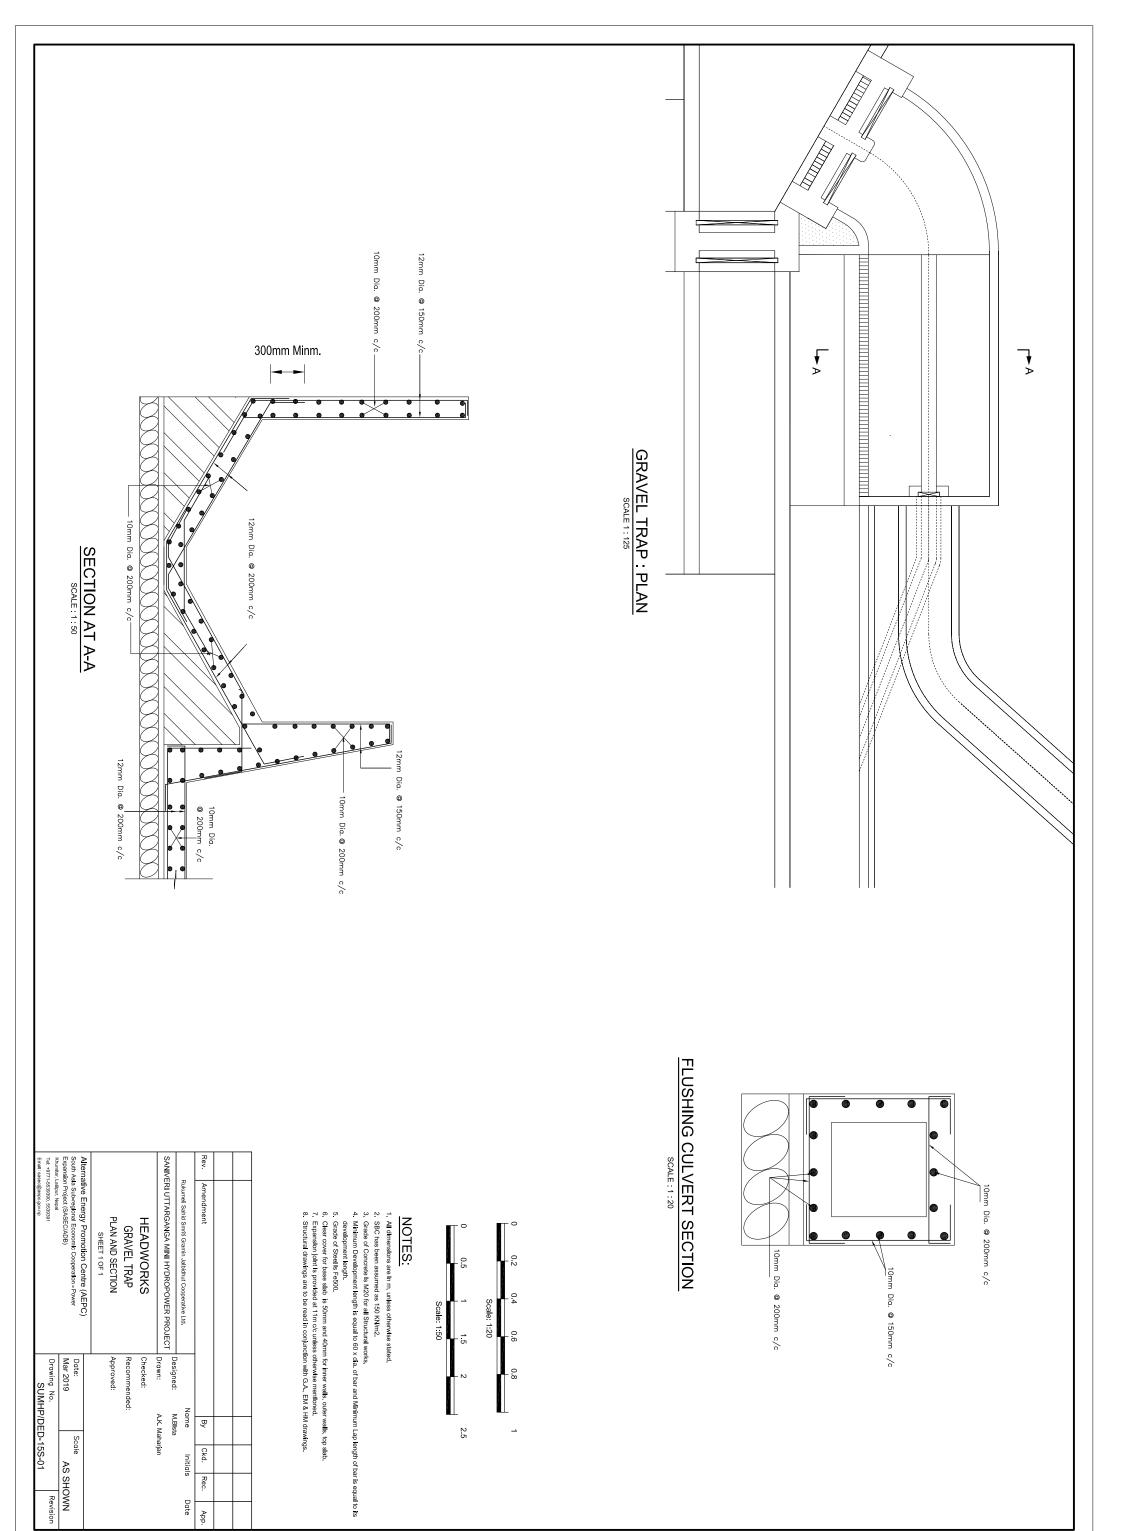



App.

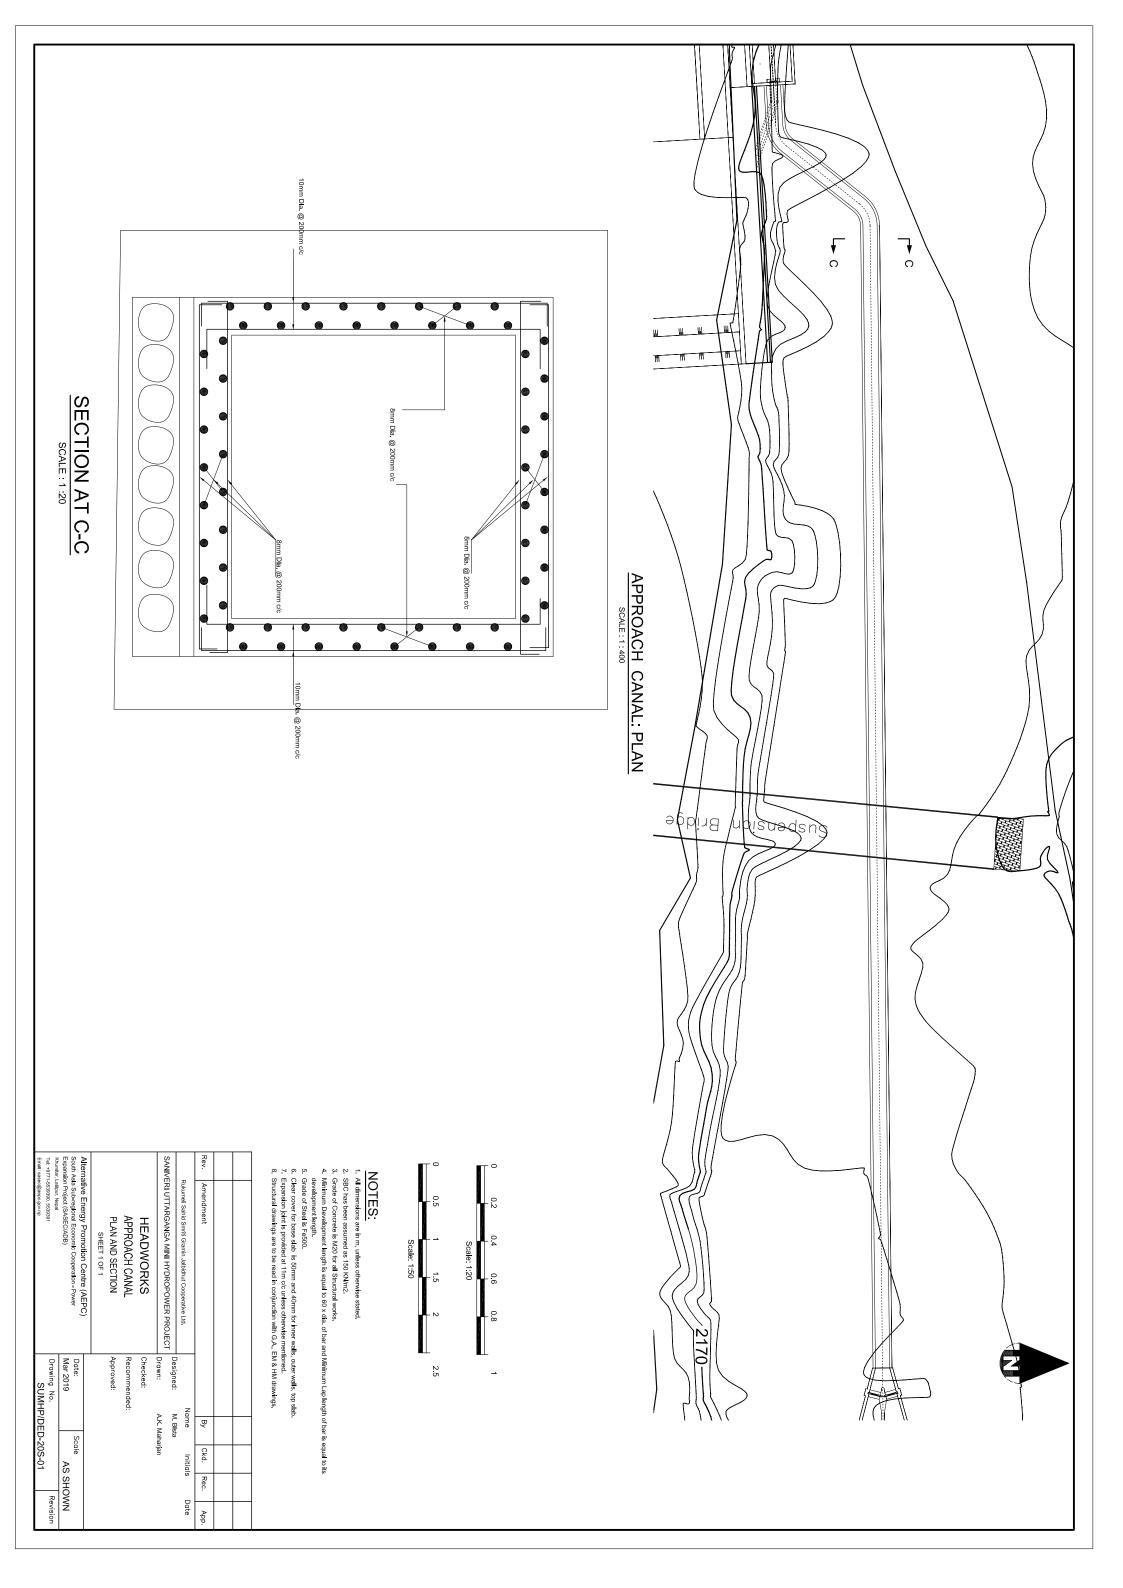


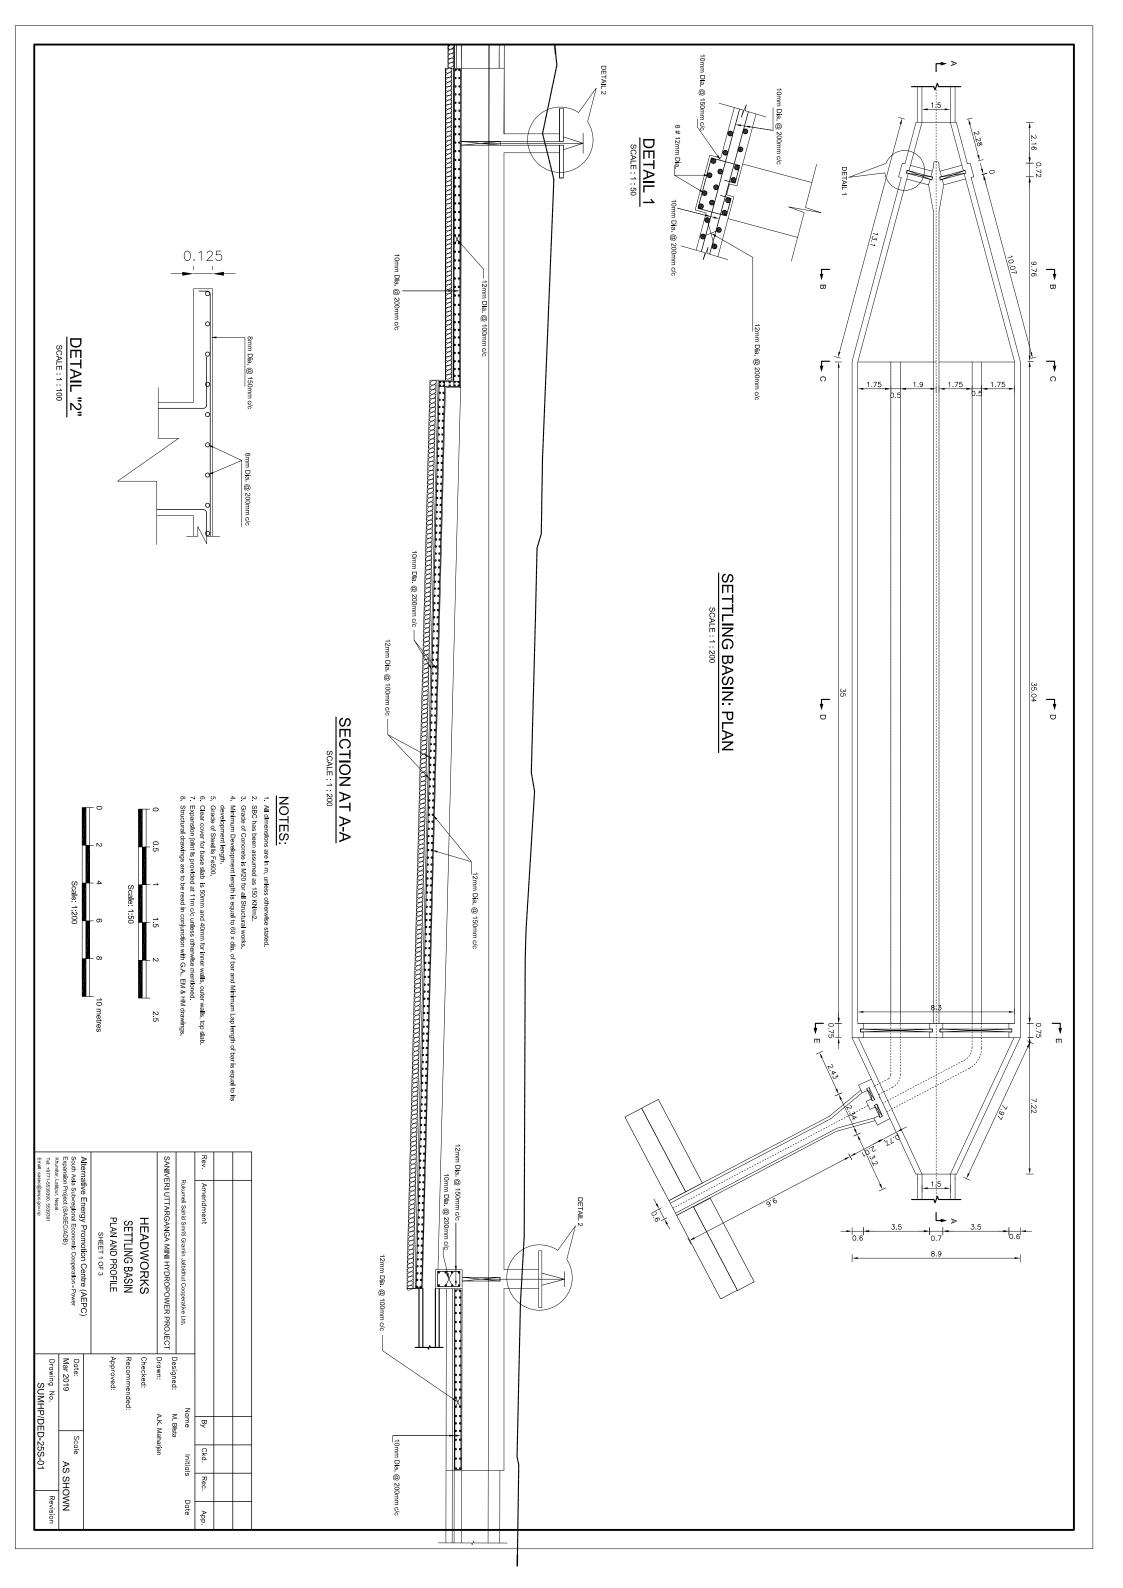


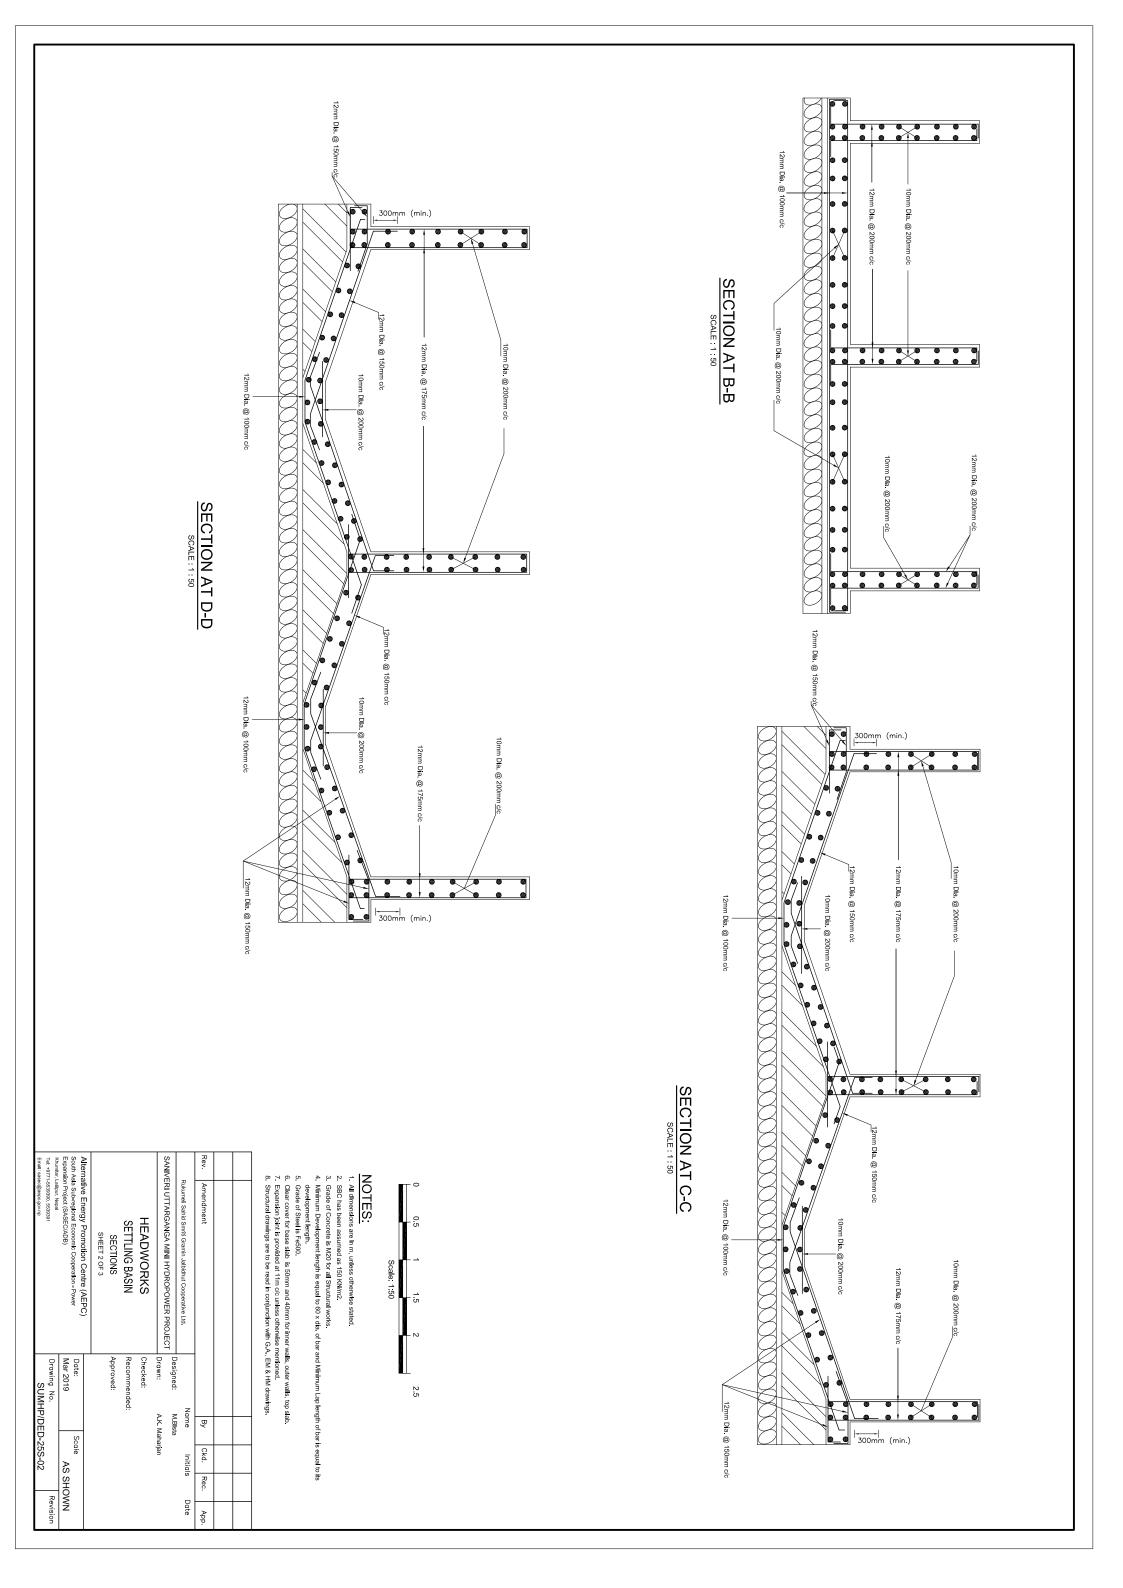

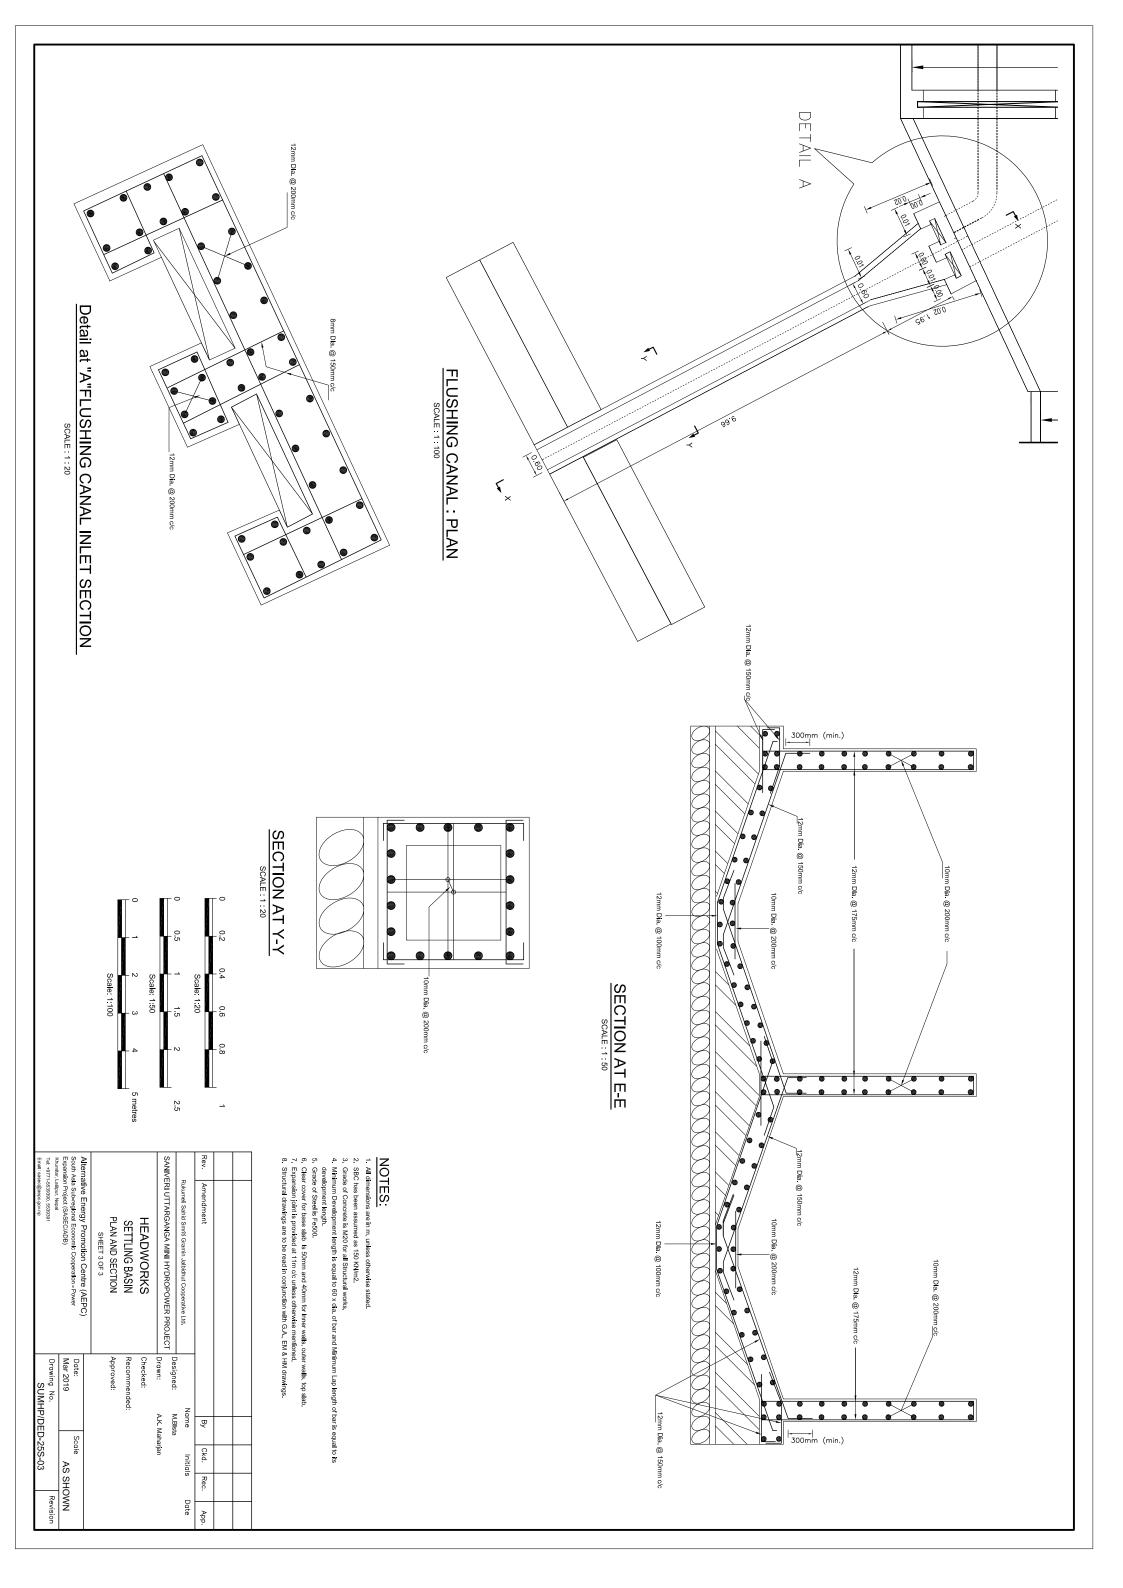

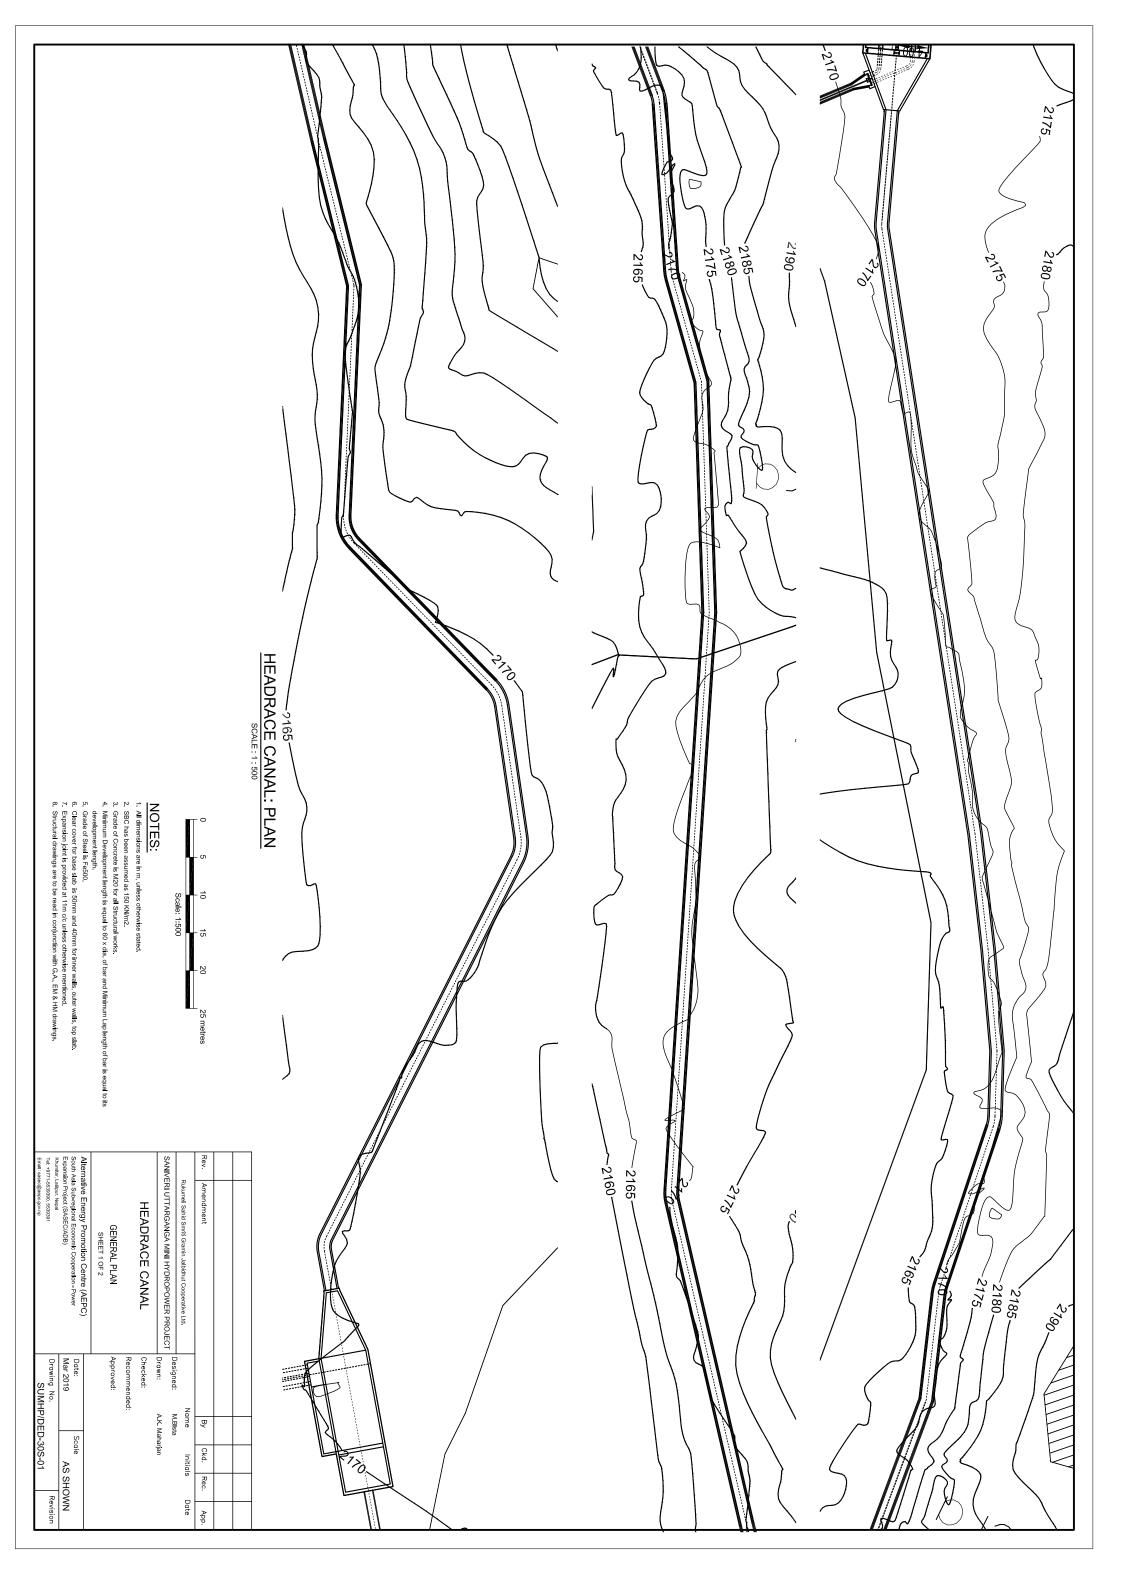

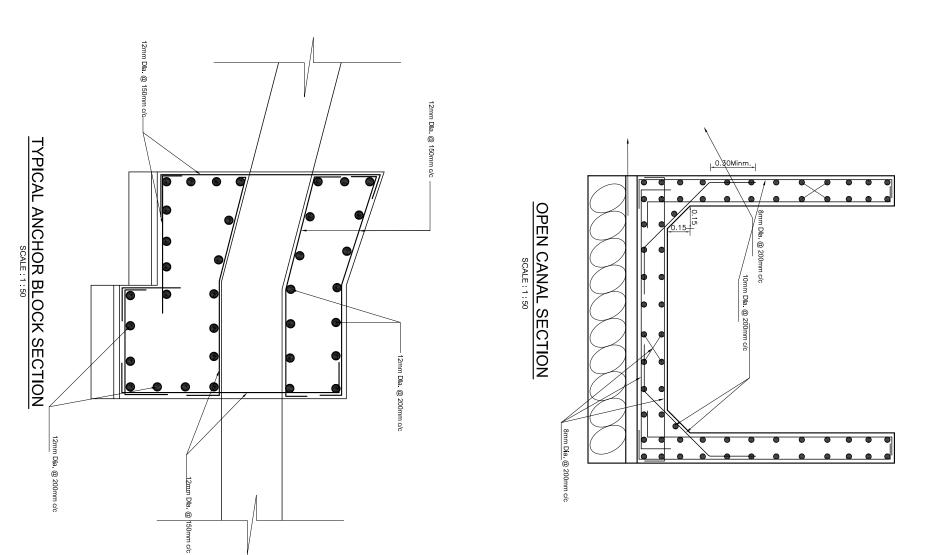

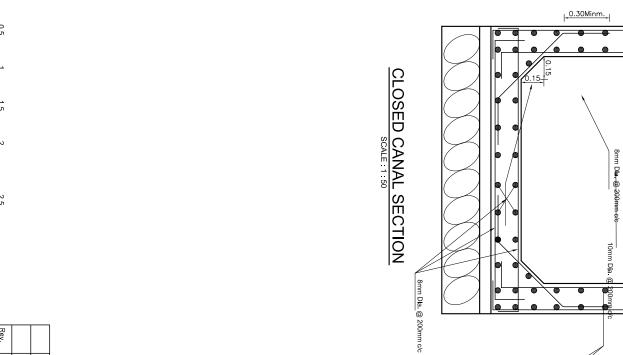

0.25L



Scale: 1:50

- NOTES:

 1. All dimensions are in m, unless otherwise stated.
 2. SBC has been assumed as 150 KN/m2.
 3. Grade of Concrete is M20 for all Structural works.
 4. Minimum Development length is equal to 60 x dia, of bar and Minimum Lap length of bar is equal to its development length.
 5. Grade of Steel is Fa500.
 6. Clear cover for base slab is 50mm and 40mm for inner walls, outer walls, top slab.
 7. Expansion join is provided at 11m of unless otherwise mentioned.
 8. Structural drawings are to be read in conjunction with G.A., EM & HM drawings.

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Khumltar, I Tel: +9771 Email: sas	South As Expansion	-			SANIVE	_	Rev.	
Khunitar, Latijour, Nepal Tel: +9771-539390, 5539391 Email: saseo@aepc.gov.np	Alternative Energy Promotion Centre (AEPC) South Asia Sub-regional Economic Cooperation - Power Expansion Project (SASEC/ADB)	PLAN AND SECTION SHEET 2 OF 2		HEADRACE CANAL	SANIVERI UTTARGANGA MINI HYDROPOWER PROJECT	Rukumeli Sahid Smriti Gramin Jalbidhut Cooperative Ltd.	Amendment	
Drawing No. SUMHP/DED-30S-02	Scale AS SHO	Approved:	Recommended:	Checked:	Drawn:	z		
/DED-3					M. Bista A. K. Maharjan	Name	Ву	
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Revisio	È					Date	Αp	ĺ

